


1 FRONT ELEVATION
 1/4" = 1'-0"

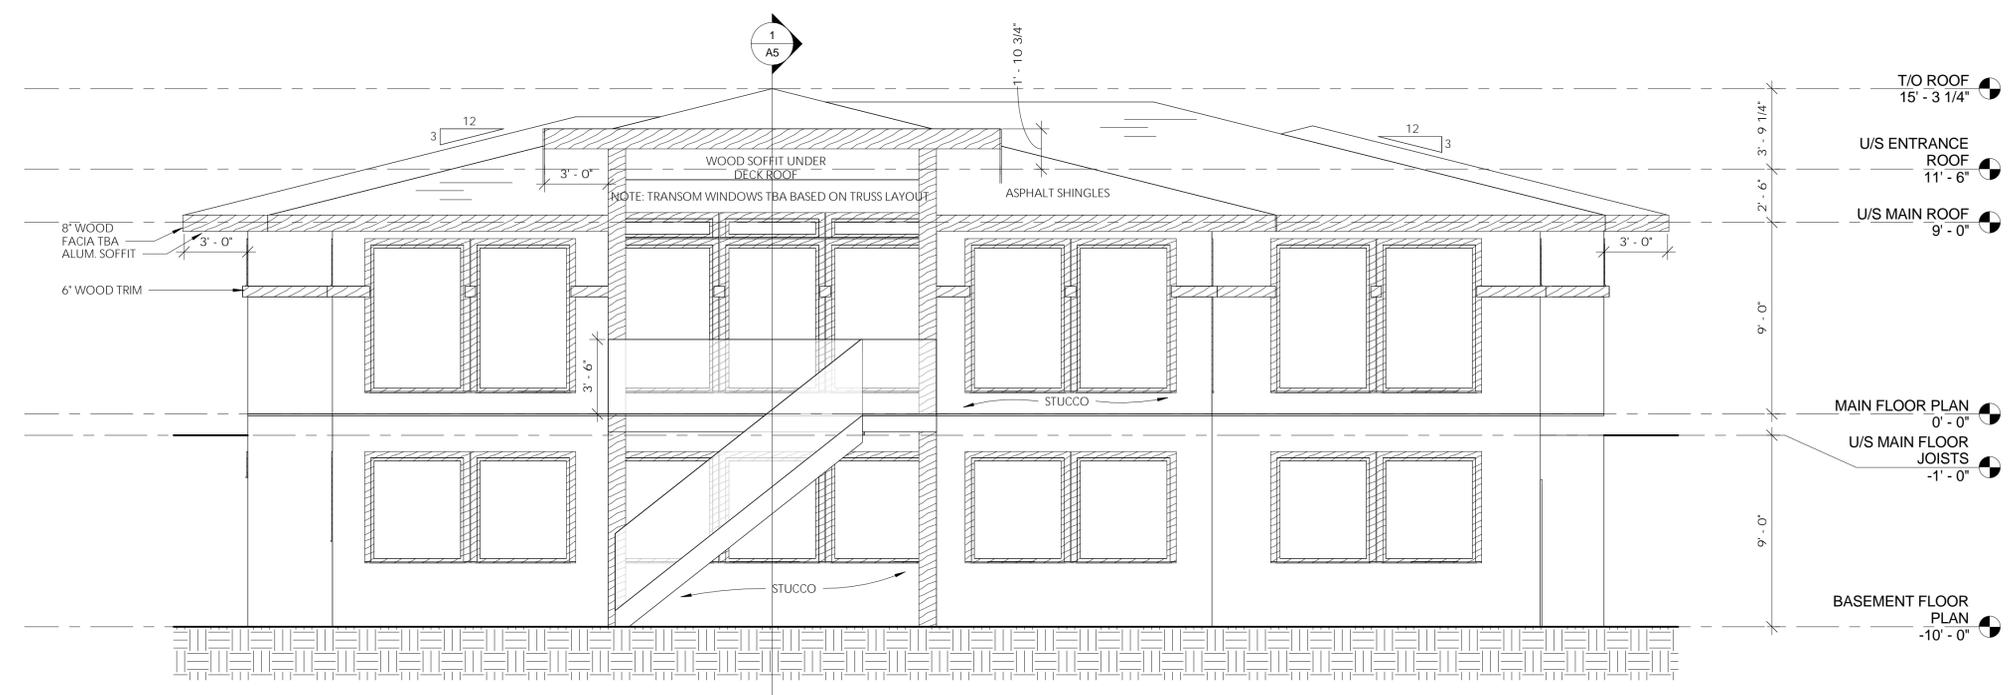

2 BACK ELEVATION
 1/4" = 1'-0"

THE CONSTRUCTION OF THIS PROJECT ON ANY SITE OTHER THAN THE SITE NOTED IN THIS PROJECT SET IS A VIOLATION OF CANADIAN COPYRIGHT LAWS

LOCATION: 110 Dee Street,
 Kamloops, B.C., V2B 3Y8

CONTACT: Danielle Fauteux, BSc, BGS, ASCT
PHONE: 250-571-2861
EMAIL: Designer@live.ca
WEBSITE: AllbyDesign.net

PROJECT ADDRESS:
 1982 QU'APPELLE BLVD,
 KAMLOOPS, B.C.

BROWN RESIDENCE

DRAWING TITLE:
 FRONT & BACK
 ELEVATIONS


DATE: **REVISIONS:**

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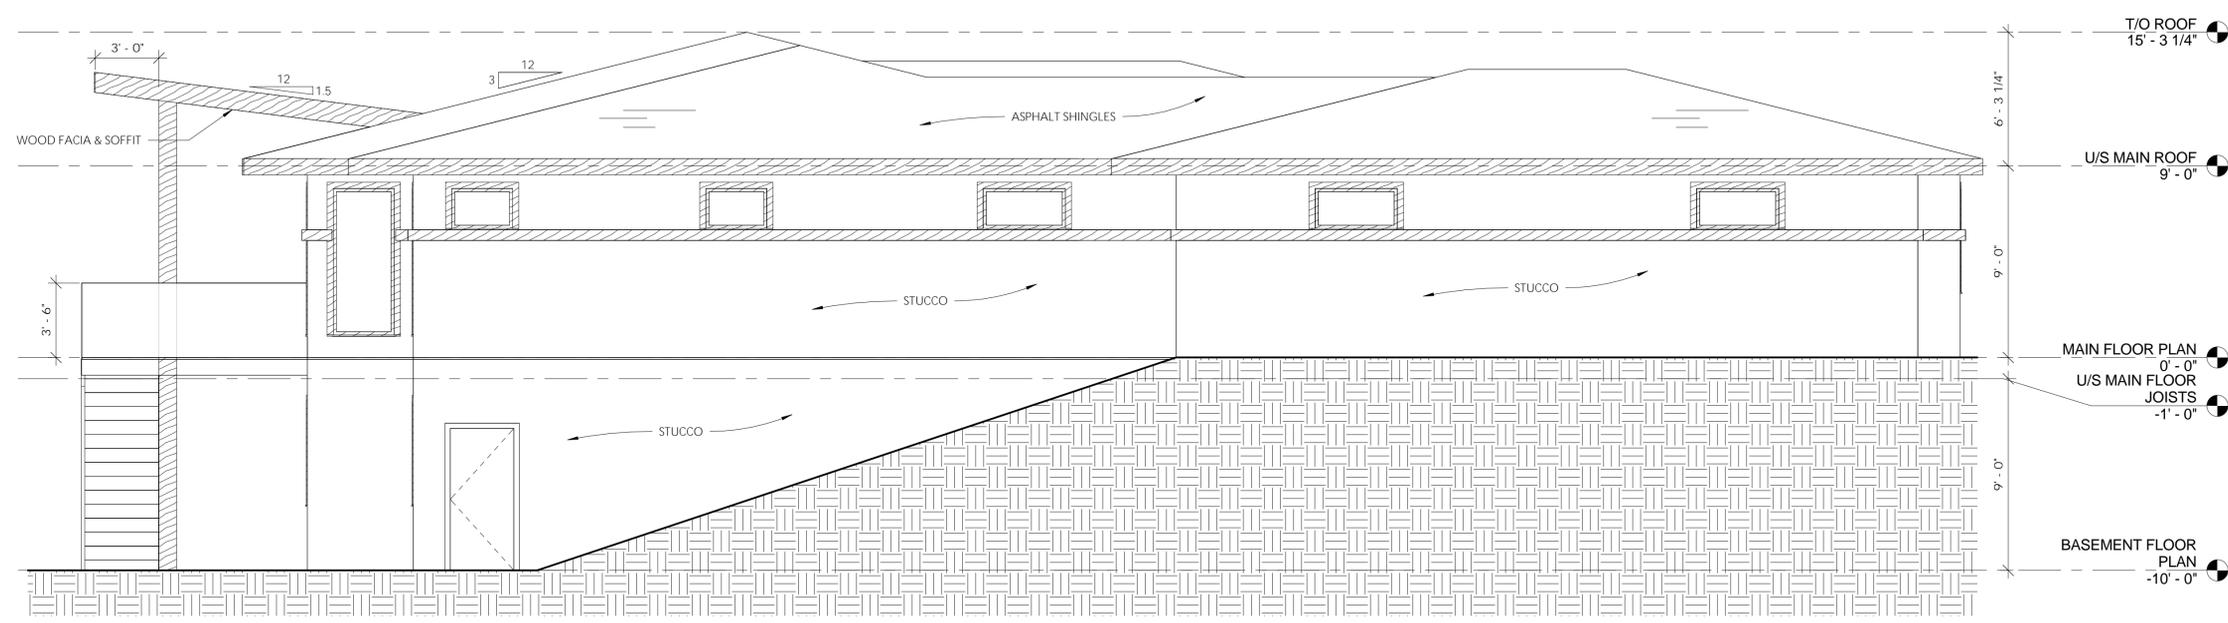
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|---------------------------------------|------------------------------------|
| SCALE 1/4" = 1'-0" | DRAWN BY D. FAUTEUX |
| PROJECT START DATE MAY 3/16 | LAST REVISED: JUN. 10/16 |

DRAWING NO.

A3

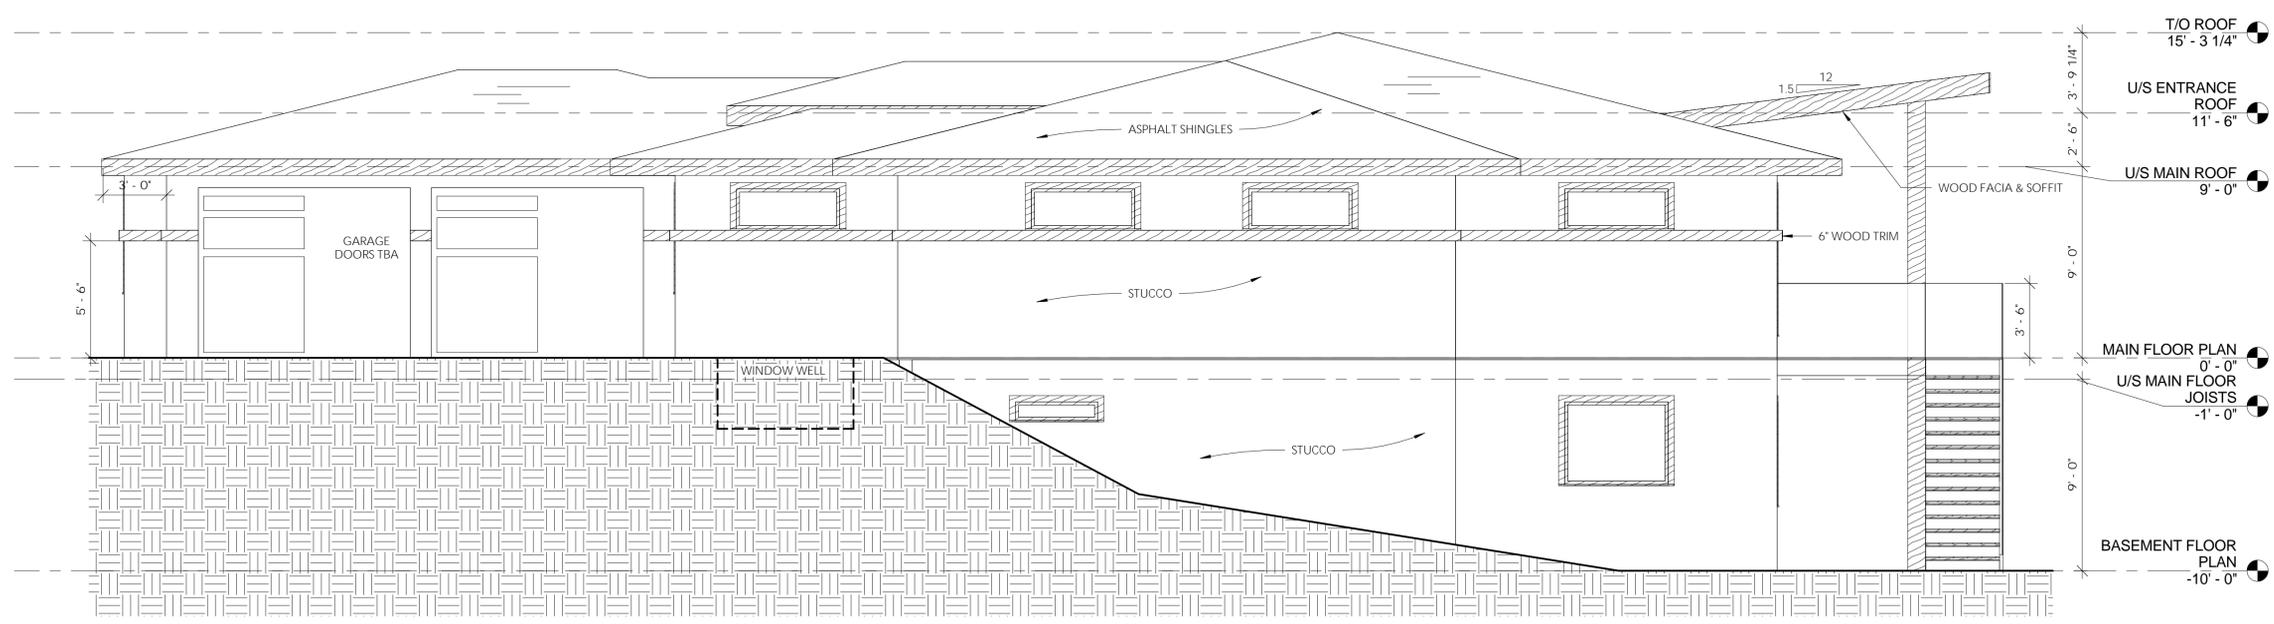

1
A4
RIGHT ELEVATION
1/4" = 1'-0"



2
A4
LEFT ELEVATION
1/4" = 1'-0"

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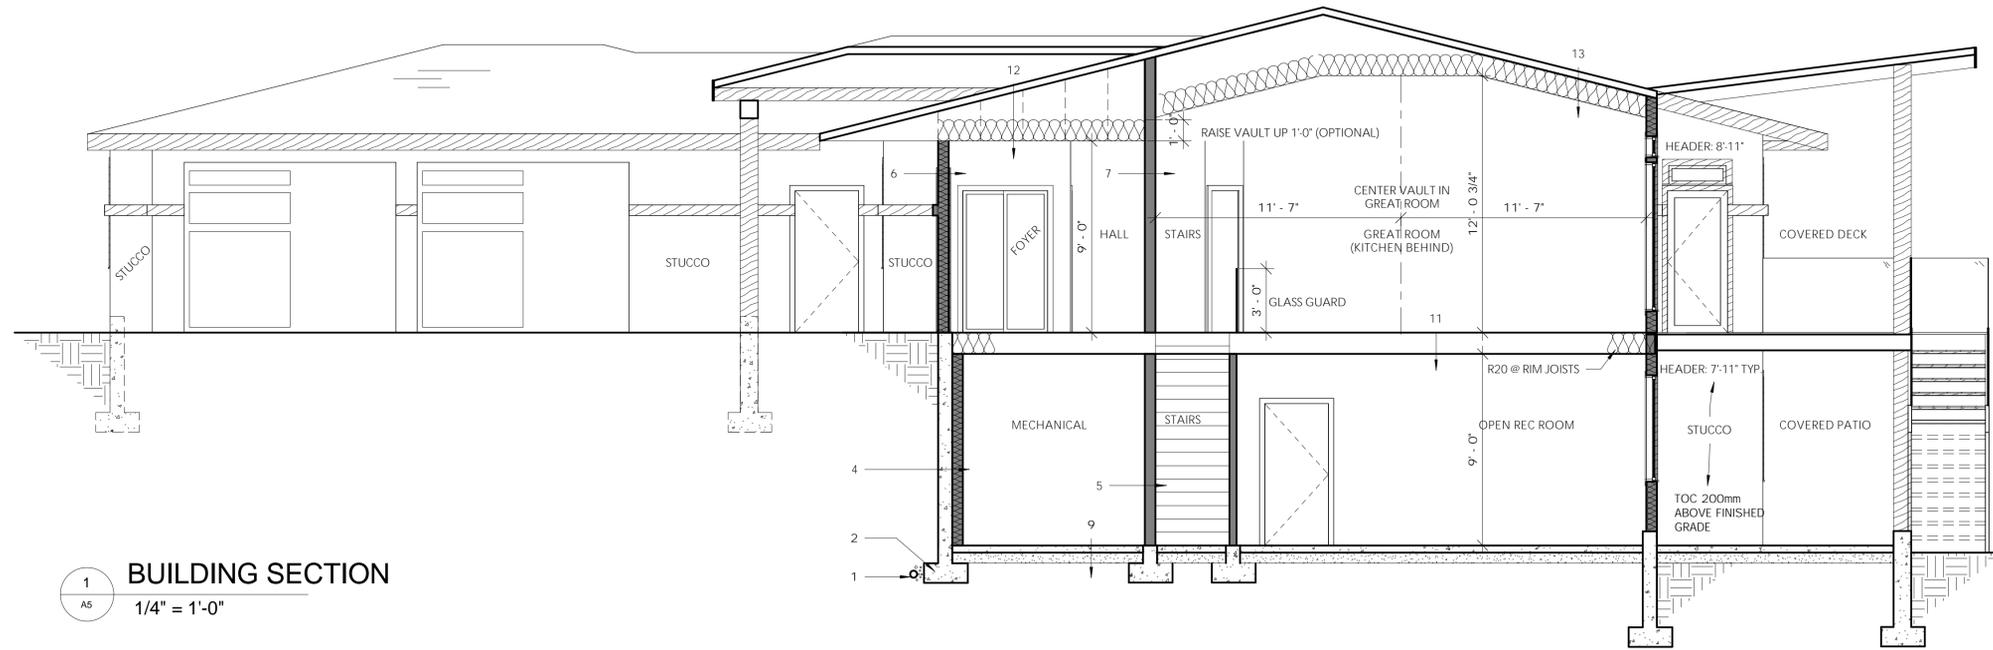
BROWN RESIDENCE

DRAWING TITLE:
RIGHT & LEFT
ELEVATIONS

| DATE: | REVISIONS: |
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| SCALE 1/4" = 1'-0" | DRAWN BY D. FAUTEUX |
| PROJECT START DATE MAY 3/16 | LAST REVISED: JUN. 10/16 |

DRAWING NO.
A4




1
AS
BUILDING SECTION
1/4" = 1'-0"

SECTION NOTES:

- 1 - DRAINAGE:
4" DRAIN TILE
6" MIN. DRAIN ROCK
(OR AS SPECIFIED BY GEOTECH.)
- 2 - FOOTINGS:
24" X 8" CONT. CONC. FTGS*
(BELOW FROST LINE)
C/W REINFORCING BARS TO BUILDERS SPEC.
*SEE ENG. FDN PLAN
- 3 - PLATE TO FOUNDATION CONNECTION: (NOT SHOWN)
2X6 (OR 2X4) SILL PLATE
SILL GASKET OR MIN. 6 MIL POLY V.B.
1/2" DIAMETER ANCHOR BOLTS
@ 6'-0" O.C. MAX.
- 4 - EXTERIOR FDN WALLS:
0.00 ASPHALT DAMPROOFING
2.78 8" CONC. WALL
(C/W REINFORCING BARS TO BUILDERS SPEC.)
1/2" AIR SPACE
2X6 STUDS @ 24" O.C.
R20 BATT INSUL.
0.00 6 MIL POLY V.B.
0.08 1/2" GWB
0.12 INTERIOR AIR FILM
2.98 RSI = COMPLIANT
- 5 - INTERIOR BEARING WALLS:
2X6 (OR 2X4) STUDS AT 16" O.C.
1/2" G.W.B. EA. SIDE
CONT. CONC. FTG*
(BELOW FROST LINE)
C/W REINFORCING BARS TO BUILDERS SPEC.
*SEE ENG. FDN PLAN
- 6 - EXTERIOR WALLS - STUCCO:
0.03 EXTERIOR AIR FILM
0.019 ACRYLIC STUCCO
0.00 60 MINUTE BLDG PAPER
0.11 1/2" PLYWOOD SHEATHING
2.80 2X6 STUDS @ 24" O.C. - SECOND & MAIN FLOOR
R24 BATT INSULATION
6 MIL POLY V.B.
0.08 1/2" G.W.B.
0.12 INTERIOR AIR FILM
3.159 RSI = COMPLIANT
- 7 - INTERIOR PARTITIONS:
2X4 (OR 2X6) STUDS @ 16" O.C.
1/2" G.W.B. EA. SIDE

- 8 - GARAGE PARTITION (NOT SHOWN)
0.03 EXTERIOR AIR FILM
2.66 2X6 STUDS @ 16" O.C.
R24 BATT INSULATION
0.16 1/2" G.W.B. EA. SIDE
0.12 INTERIOR AIR FILM
2.98 RSI = COMPLIANT
- 9 - BASEMENT CONCRETE SLAB:
3-1/2" CONC. SLAB
C/W REINFORCING BARS TO BUILDERS SPEC.
6 MIL POLY V.B.
6" MIN. COMPACTED GRAN. FILL
- 10 - GARAGE SLAB (NOT SHOWN)
4" CONC. SLAB
C/W REINFORCING BARS TO BUILDERS SPEC.
6 MIL POLY V.B.
6" MIN. COMPACTED GRANULAR FILL
- 11 - MAIN & SECOND FLOOR:
FINISH FLOORING - SEE OWNER
3/4" T&G PLYWOOD
11-7/8" ENGINEERED FLOOR JOISTS*
*SEE MANUF. SPEC.
- 12 - ROOF & CEILING (W/ ATTIC):
0.03 EXTERIOR AIR FILM
0.08 ASPHALT SHINGLES
0.00 BUILDING PAPER
0.11 1/2" PLYWOOD SHEATHING
1.19 (11%) ENGINEERED TRUSSES
(SEE MANUF. SPEC.)
9.68 (89%) R55 BLOWN IN INSULATION
0.00 6 MIL POLY V.B.
0.08 1/2" G.W.B.
0.11 INTERIOR AIR FILM
9.16 RSI = COMPLIANT
- 13 - ROOF & CEILING (VAULTED):
0.03 EXTERIOR AIR FILM
0.08 ASPHALT SHINGLES
0.00 BUILDING PAPER
0.11 1/2" PLYWOOD SHEATHING
1.19 (11%) ENGINEERED TRUSSES
(SEE MANUF. SPEC.)
4.94 (89%) R28 BLOWN IN INSULATION
0.00 6 MIL POLY V.B.
0.08 1/2" G.W.B.
0.11 INTERIOR AIR FILM
4.94 RSI = COMPLIANT
- 14 - FACIA, SOFFIT, GUTTERS:
SEE ELEVATIONS
- 15 - STAIRS:
-16 RISERS @ 7.5" EA.
-15 RUNS @ 10" + 1" NOSING EA.
-6'-5" (1950mm) HEADROOM MIN.
-3'-0" HAND RAIL

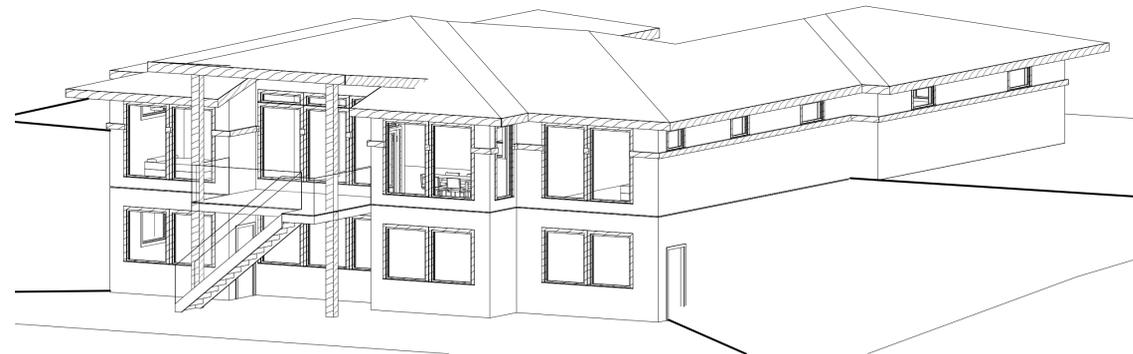

2
AS
BACK LEFT 3D VIEW



3
AS
BACK RIGHT 3D VIEW

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PROJECT ADDRESS:
1982 QU'APPELLE BLVD,
KAMLOOPS, B.C.

BROWN RESIDENCE

DRAWING TITLE:
BUILDING SECTION

DATE: **REVISIONS:**

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SCALE: 1/4" = 1'-0" **DRAWN BY:** D. FAUTEUX

PROJECT START DATE: MAY 3/16 **LAST REVISED:** JUN. 10/16

DRAWING NO.:

A5